APPROVED JURISDICTIONAL DETERMINATION FORM U.S. Army Corps of Engineers

This form should be completed by following the instructions provided in Section IV of the JD Form Instructional Guidebook.

SECTION I: BACKGROUND INFORMATION

A. REPORT COMPLETION DATE FOR APPROVED JURISDICTIONAL DETERMINATION (JD): 4 March 2019

B. ST PAUL, MN DISTRICT OFFICE, FILE NAME, AND NUMBER: 2018-03622-JMB

C. PROJECT LOCATION AND BACKGROUND INFORMATION:

State: Wisconsin County/parish/borough: Milwaukee

City: St. Francis

Center coordinates of site (lat/long in degree decimal format): Lat. 42.967716° N, Long. -87.3850508° W.

Universal Transverse Mercator:

Name of nearest waterbody: Lake Michigan

Name of watershed or Hydrologic Unit Code (HUC): 04040002

Check if map/diagram of review area and/or potential jurisdictional areas is/are available upon request.

Check if other sites (e.g., offsite mitigation sites, disposal sites, etc...) are associated with this action and are recorded on a different JD form.

D. REVIEW PERFORMED FOR SITE EVALUATION (CHECK ALL THAT APPLY):

- Office (Desk) Determination. Date: 29 January 2019
- **Field Determination**. Date(s):

SECTION II: SUMMARY OF FINDINGS A. RHA SECTION 10 DETERMINATION OF JURISDICTION.

There are no "navigable waters of the U.S." within Rivers and Harbors Act (RHA) jurisdiction (as defined by 33 CFR part 329) in the review area.

B. CWA SECTION 404 DETERMINATION OF JURISDICTION.

There are no"waters of the U.S." within Clean Water Act (CWA) jurisdiction (as defined by 33 CFR part 328) in the review area.

- 1. Waters of the U.S.: N/A
- 2. Non-regulated waters/wetlands (check if applicable):¹
 - Potentially jurisdictional waters and/or wetlands were assessed within the review area and determined to be not jurisdictional. Explain: Wetland 1 (0.01 acres), wetland 2 (0.02 acres), and wetland 3 (0.32 acres) are located in closed depressions surrounded by prevolusly developed residential/commerical property. A paved walking path is located to the east of the delineated wetlands offisite, and STH 32 borders the project site to the west. The wetlands are approximately 300' from Lake Michigan, and there is an approximately 45' drop in elevation down to the water level of Lake Michigan over that distance. The delineated wetlands occur in small depressions that collect surface water from the surrounding landscape; subsurface hydrology was likely affected when a nearby ravine was filled sometime in the 1990's. The wetlands do not have any unbroken suface or shallow subsurface connections to Lake Michigan and are not mapped within the 100-year flood plain. The wetlands are not adjacent (bordering, contiguous, or neighboring) to any other WOUS and are not separated from other WOUS by man-made dikes or barries, natural river berms, or beach dunes. Due to the distance between these wetlands and the nearest tributary there is no science-based inference (ex. does not support life cycles of amphibians or anadromous and catadramous fish) that supports an ecological connection. Additionally, there is no link to interstate or foreign commerce and they are not used by interstate or foreign travelers for recreation or other purposes. These wetlands do no produce fish or shellfish that could be taken and sold in interstate or foreign commerce, and are not known to be used for industrial purposes by industries in interstate commerce. Therefore, the Corps has determined that Wetland 1, Wetland 2, and Wetland 3 are hydrologically isolated and are not regulated by the Corps under Section 404 of the Clean Water Act.

SECTION III: CWA ANALYSIS

A. TNWs AND WETLANDS ADJACENT TO TNWs: N/A

B. CHARACTERISTICS OF TRIBUTARY (THAT IS NOT A TNW) AND ITS ADJACENT WETLANDS (IF ANY): N/A

¹ Supporting documentation is presented in Section III.F.

SIGNIFICANT NEXUS DETERMINATION: N/A C.

D. DETERMINATIONS OF JURISDICTIONAL FINDINGS. THE SUBJECT WATERS/WETLANDS ARE (CHECK ALL THAT APPLY): N/A

E. ISOLATED [INTERSTATE OR INTRA-STATE] WATERS, INCLUDING ISOLATED WETLANDS, THE USE, DEGRADATION OR DESTRUCTION OF WHICH COULD AFFECT INTERSTATE COMMERCE, INCLUDING ANY SUCH WATERS (CHECK ALL THAT APPLY): N/A

NON-JURISDICTIONAL WATERS, INCLUDING WETLANDS (CHECK ALL THAT APPLY): F

If potential wetlands were assessed within the review area, these areas did not meet the criteria in the 1987 Corps of Engineers Wetland Delineation Manual and/or appropriate Regional Supplements.

 \boxtimes Review area included isolated waters with no substantial nexus to interstate (or foreign) commerce.

Prior to the Jan 2001 Supreme Court decision in "SWANCC," the review area would have been regulated based solely on the \square "Migratory Bird Rule" (MBR).

Waters do not meet the "Significant Nexus" standard, where such a finding is required for jurisdiction. Explain:

Other (explain, if not covered above):

Provide acreage estimates for non-jurisdictional waters in the review area, where the sole potential basis of jurisdiction is the MBR factors (i.e., presence of migratory birds, presence of endangered species, use of water for irrigated agriculture), using best professional judgment (check all that apply):

Non-wetland waters (i.e., rivers, streams): linear feet width (ft).

Lakes/ponds: acres.

Other non-wetland waters: acres. List type of aquatic resource:

Wetlands: 0.35 acres. \boxtimes

Provide acreage estimates for non-jurisdictional waters in the review area that do not meet the "Significant Nexus" standard, where such a finding is required for jurisdiction (check all that apply):

Non-wetland waters (i.e., rivers, streams): linear feet, width (ft).

Lakes/ponds: acres.

Other non-wetland waters: acres. List type of aquatic resource:

Wetlands: acres.

SECTION IV: DATA SOURCES.

A. SUPPORTING DATA. Data reviewed for JD (check all that apply - checked items shall be included in case file and, where checked and requested, appropriately reference sources below):

Maps, plans, plots or plat submitted by or on behalf of the applicant/consultant: Application materials submitted by

Campbell Capital Group, LLC on 29 November 2018.

Data sheets prepared/submitted by or on behalf of the applicant/consultant.

Office concurs with data sheets/delineation report.

Office does not concur with data sheets/delineation report.

Data sheets prepared by the Corps:

- Corps navigable waters' study:
- U.S. Geological Survey Hydrologic Atlas:
 - USGS NHD data.

USGS 8 and 12 digit HUC maps.

U.S. Geological Survey map(s). Cite scale & quad name: 1:24K - St. Francis

USDA Natural Resources Conservation Service Soil Survey. Citation: NRCS Soils Data \boxtimes

National wetlands inventory map(s). Cite name:

- \boxtimes State/Local wetland inventory map(s): Wisconsin Wetland Inventory
- FEMA/FIRM maps:

100-year Floodplain Elevation is:	(National Geodectic Vertical Datum of 1929)

Photographs: Aerial (Name & Date):

or \boxtimes Other (Name & Date): Site photos dated 7/2/2018


- Previous determination(s). File no. and date of response letter:
- Applicable/supporting case law:
 - Applicable/supporting scientific literature:
- Other information (please specify): Project narrative submitted 29 November 2018. \bowtie

B. ADDITIONAL COMMENTS TO SUPPORT JD: The Corps has determined that the wetlands onsite are hydrologically isolated, and are therefore not regulated by the Corps under Section 404 of the Clean Water Act.

SITE CIVIL AND LANDSCAPE PL FOR 4200 S LAKE DRIVE ST. FRANCIS, WI

LEGEND (PROPOSED FEATURES)

(PROPOSEL) FEATURES)
	TREE REMOVAL EXISTING CONCRETE PAVEMENT TO BE REMOVED EXISTING ASPHALT PAVEMENT TO BE
	REMOVED EXISTING GRAVEL TO BE REMOVED
	EXISTING BUILDING/STRUCTURE
-XXXXXXXXXXX	SAWCUT LINE
	PROPOSED PROPERTY LINE PROPOSED SITE LIGHTING (DESIGNED BY OTHERS, FOR REFERENCE ONLY)
	MONUMENT SIGNS (CONSTRUCTION DETAILS BY OTHERS) SIGN
	PROPOSED ASPHALT PATH
	PROPOSED CONCRETE SIDEWALK
	HEAVY-DUTY ASPHALT PAVEMENT
	STANDARD-DUTY ASPHALT PAVEMENT
	COLORED AND STAMPED CONCRETE
	PROPOSED 18" REJECT CURB & GUTTER (AS SHOWN ON SITE PLAN)
	PROPOSED 18" STANDARD CURB & GUTTER (AS SHOWN ON SITE PLAN)
Č. VAN	PROPOSED ACCESSIBLE PAVEMENT MARKING VAN ACCSSSIBLE STALL
	PROPOSED TYPE 3 CURB RAMP (SEE DETAIL SHEET. NOTE LINEWORK ON PLAN IS SYMBOLIC ONLY.)
	PROPOSED TYPE 3A CURB RAMP (SEE DETAIL SHEET. NOTE LINEWORK ON PLAN IS SYMBOLIC ONLY.)
	PROPOSED TYPE 4 CURB RAMP (SEE DETAIL SHEET. NOTE LINEWORK ON PLAN IS SYMBOLIC ONLY.)
	PROPOSED TYPE 4A CURB RAMP (SEE DETAIL SHEET. NOTE LINEWORK ON PLAN IS SYMBOLIC ONLY.)
	PROPOSED TYPE 7 CURB RAMP (SEE DETAIL SHEET. NOTE LINEWORK ON PLAN IS SYMBOLIC ONLY.)
	DOOR STRUCTURAL RETAINING WALL – (DESIGNED BY OTHERS)
— — 869.5 —	PROPOSED 0.5-FOOT GRADE CONTOUR (ONLY USED WHEN CRITICAL)
	PROPOSED 1-FOOT GRADE CONTOUR PROPOSED 5-FOOT GRADE CONTOUR
869 870	CHAMPION CT. 1-FOOT GRADE CONTOUR CHAMPION CT. 5-FOOT GRADE CONTOUR
877.70 × (877.70)	PROPOSED SPOT GRADE
(877.70) X 877.70 TW	PROPOSED TOP OF CURB PROPOSED FINISHED GRADE AT TOP OF WALL
877.00 BW	PROPOSED FINISHED GRADE AT BASE OF WALL
\checkmark	PROPOSED TEMPORARY STRAW WATTLE DITCH CHECK
0	PROPOSED INLET PROTECTION PROPOSED SILT FENCE
	YEAR-1 CONSTRUCTION
	PROPOSED SILT FENCE YEAR-2 CONSTRUCTION
	PROPOSED TEMPORARY DIVERSION SWALE & BERM
$\square \square $	PROPOSED LEVEL SPREADER
	TEMPORARY CONSTRUCTION ENTRANCE
	PROPOSED PERMANENT TURF REINFORCEMENT MAT
	PROPOSED TEMPORARY EROSION CONTROL FABRIC IN FLOW LINE. CLASS I, TYPE B.
	PROPOSED RIPRAP
	PROPOSED GAS LINE
E тт	
— — — w — sto	PROPOSED WATER MAIN PROPOSED STORM SEWER
— — sio — s—	PROPOSED SANITARY SEWER
* M	PROPOSED FIRE DEPARTMENT CONNECTION PROPOSED WATER VALVE
A 	PROPOSED FIRE HYDRANT PROPOSED INLET
•	PROPOSED STORM MANHOLE
• ©	PROPOSED AREA DRAIN PROPOSED SANITARY MANHOLE
-	PROPOSED 100-YR OVERLAND FLOW DIRECTION

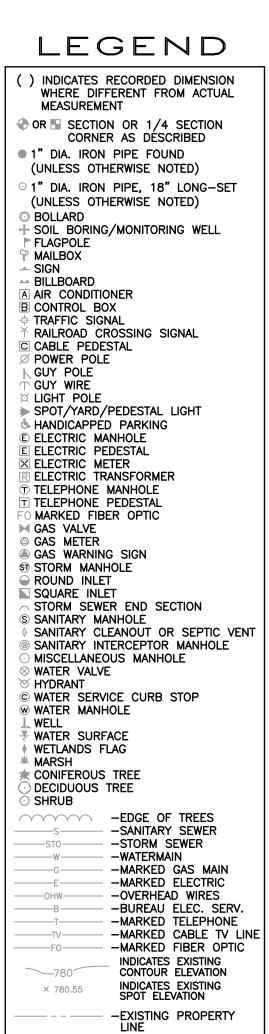

-EXISTING EASEMENT

BENCHMARK INFORMATION:


NW FLANGE BOLT ON HYD., EL=660.75 EAST SIDE OF S LAKE DRIVE

NORTH FLANGE BOLT ON HYD., EL=665.89 WEST SIDE OF S LAKE DRIVE, SOUTH OF E LUNHAM AVENUE

CONC MON W/ BRASS CAP, EL=653.31 SE CORNER, NE $\frac{1}{4}$ SECTION 23, T6N, R22E

OWNER/DEVELOPER: CAMPBELL CAPITAL GROUP, LLC 5887 GLENRIDGE DRIVE NE SUITE 360 SANDY SPRINGS, GEORGIA 30328 PH.: 678.485.3672 (MOBILE) E-MAIL: Mcampbell1@icloud.com

ΜΑΡ VICINITY

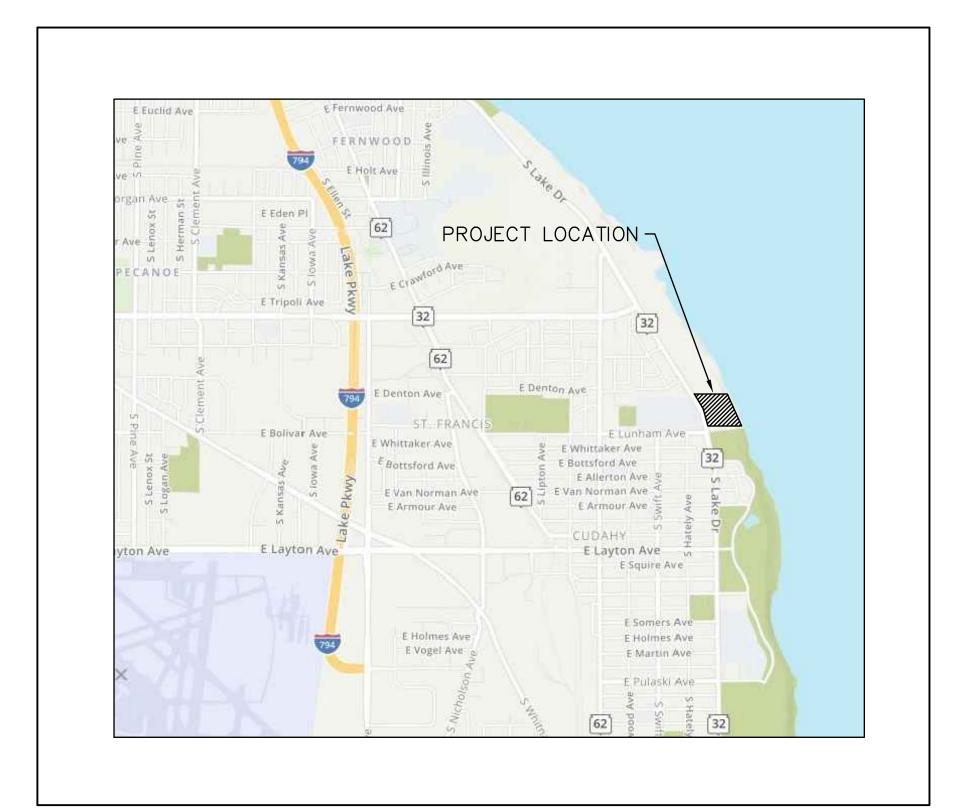





16745 W. Bluemound Road Brookfield, WI 53005-5938 (262) 781-1000 rasmith.com

ARCHITECT:

POOLE & POOLE ARCHITECTURE 3736 WINTERFIELD ROAD SUITE 102 MIDLOTHIAN, VA 23113 PH.: 804-225-0215 E-MAIL: mpool@2pa.net

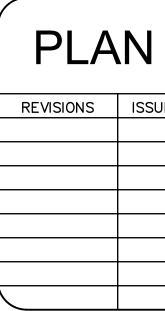

	S			DATE			
<u>SHEET NO.</u> C000 C100 C200 C201–C202 C300 C400 C401–C402 C500	DESCRIP COVER SH SITE PLAN OVERALL O DETAILED EROSION O OVERALL O	EET GRADING PLAN GRADING PLANS CONTROL PLAN JTILITY PLAN UTILITY PLANS			16745 W. Bluemound Road Brookfield, WI 53005-5938	CREATIVITY BEYOND ENGINEERING rasmith.com	Brookfield, WI Appleton, WI Madison, WI Cedarburg, WI Mount Pleasant, WI Naperville, IL Pittsburgh, PA Irvine, CA
L100-L102	LANDSCAP				4200 S LAKE DRIVE CITY OF ST. FRANCIS, WI	COVER SHEET	
DATE SHEET		18/2018 ISSUED FOR:		S J F T	© COP R.A. Smit DATE: 10/ SCALE: N.T. OB NO. 318 PROJECT MA OM MORTE DESIGNED B	18/2018 S. 80174 ANAGER: ENSEN PL/	
		R.A.SMITH, INC. ASSUMES DAMAGES, LIABILITY OR CHANGES OR ALTERATION WITHOUT THE EXPRESSED R.A.SMITH, INC.	S NO RESPONSIBILITY FOR COSTS RESULTING FROM NS MADE TO THIS PLAN D WRITTEN CONSENT OF		CHECKED B		ER

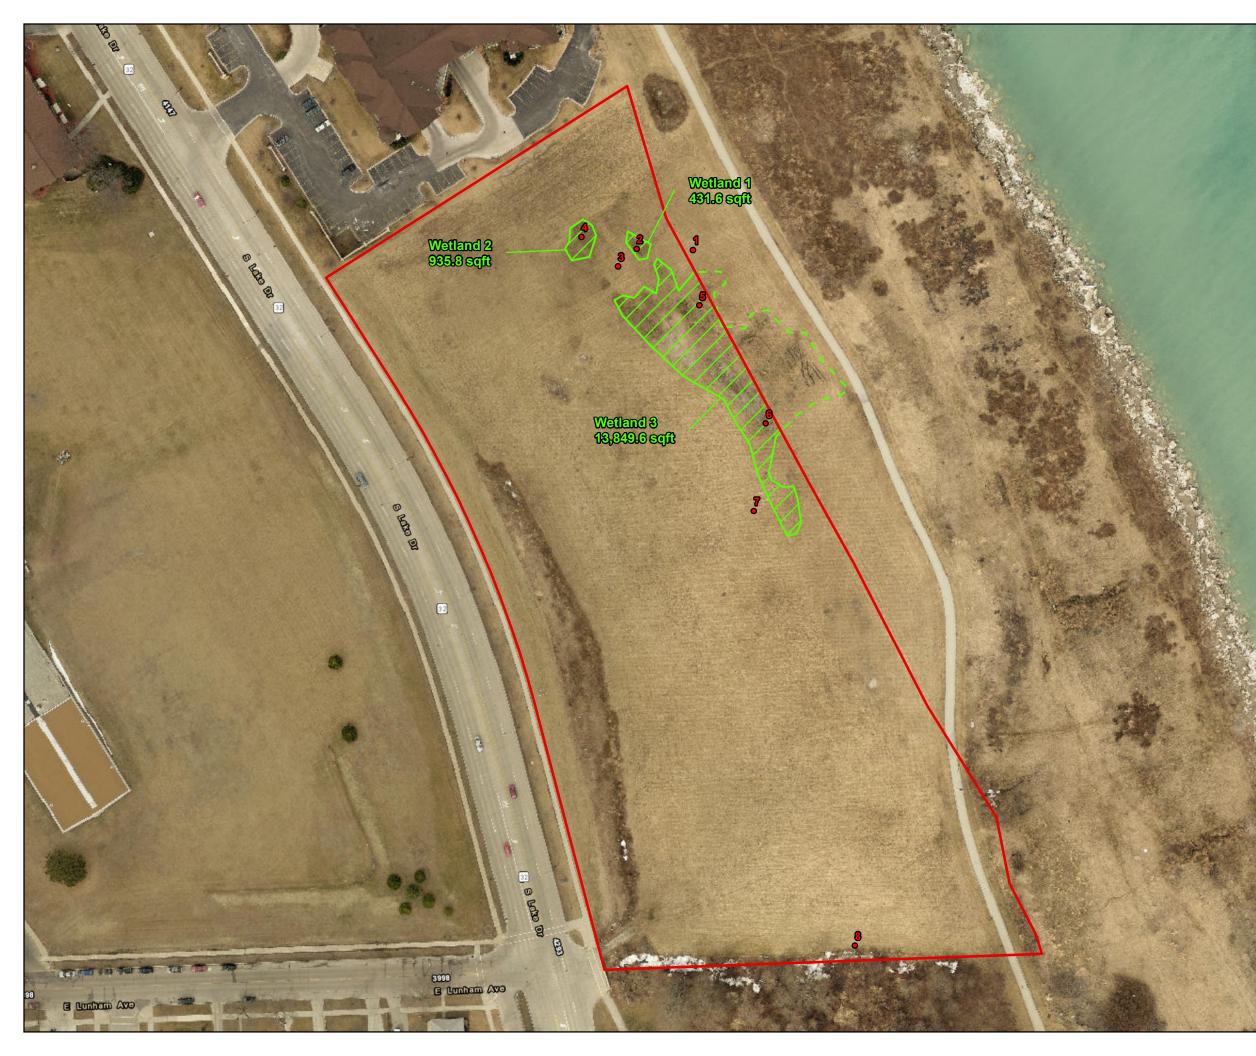



Campbell Capital Group, LLC Campbell Site - St. Francis City of St. Francis Milwaukee County, Wisconsin


Map Legend

Sampling Point
Off-site Wetland
Delineated Wetland (15,217.1 sqft)
Study Area (7.5 Acres)

Esri, HERE, Garmin, © OpenStreetMap contributors Milwaukee County Land Information Office

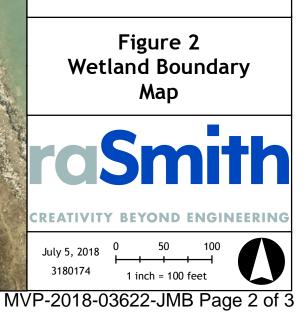

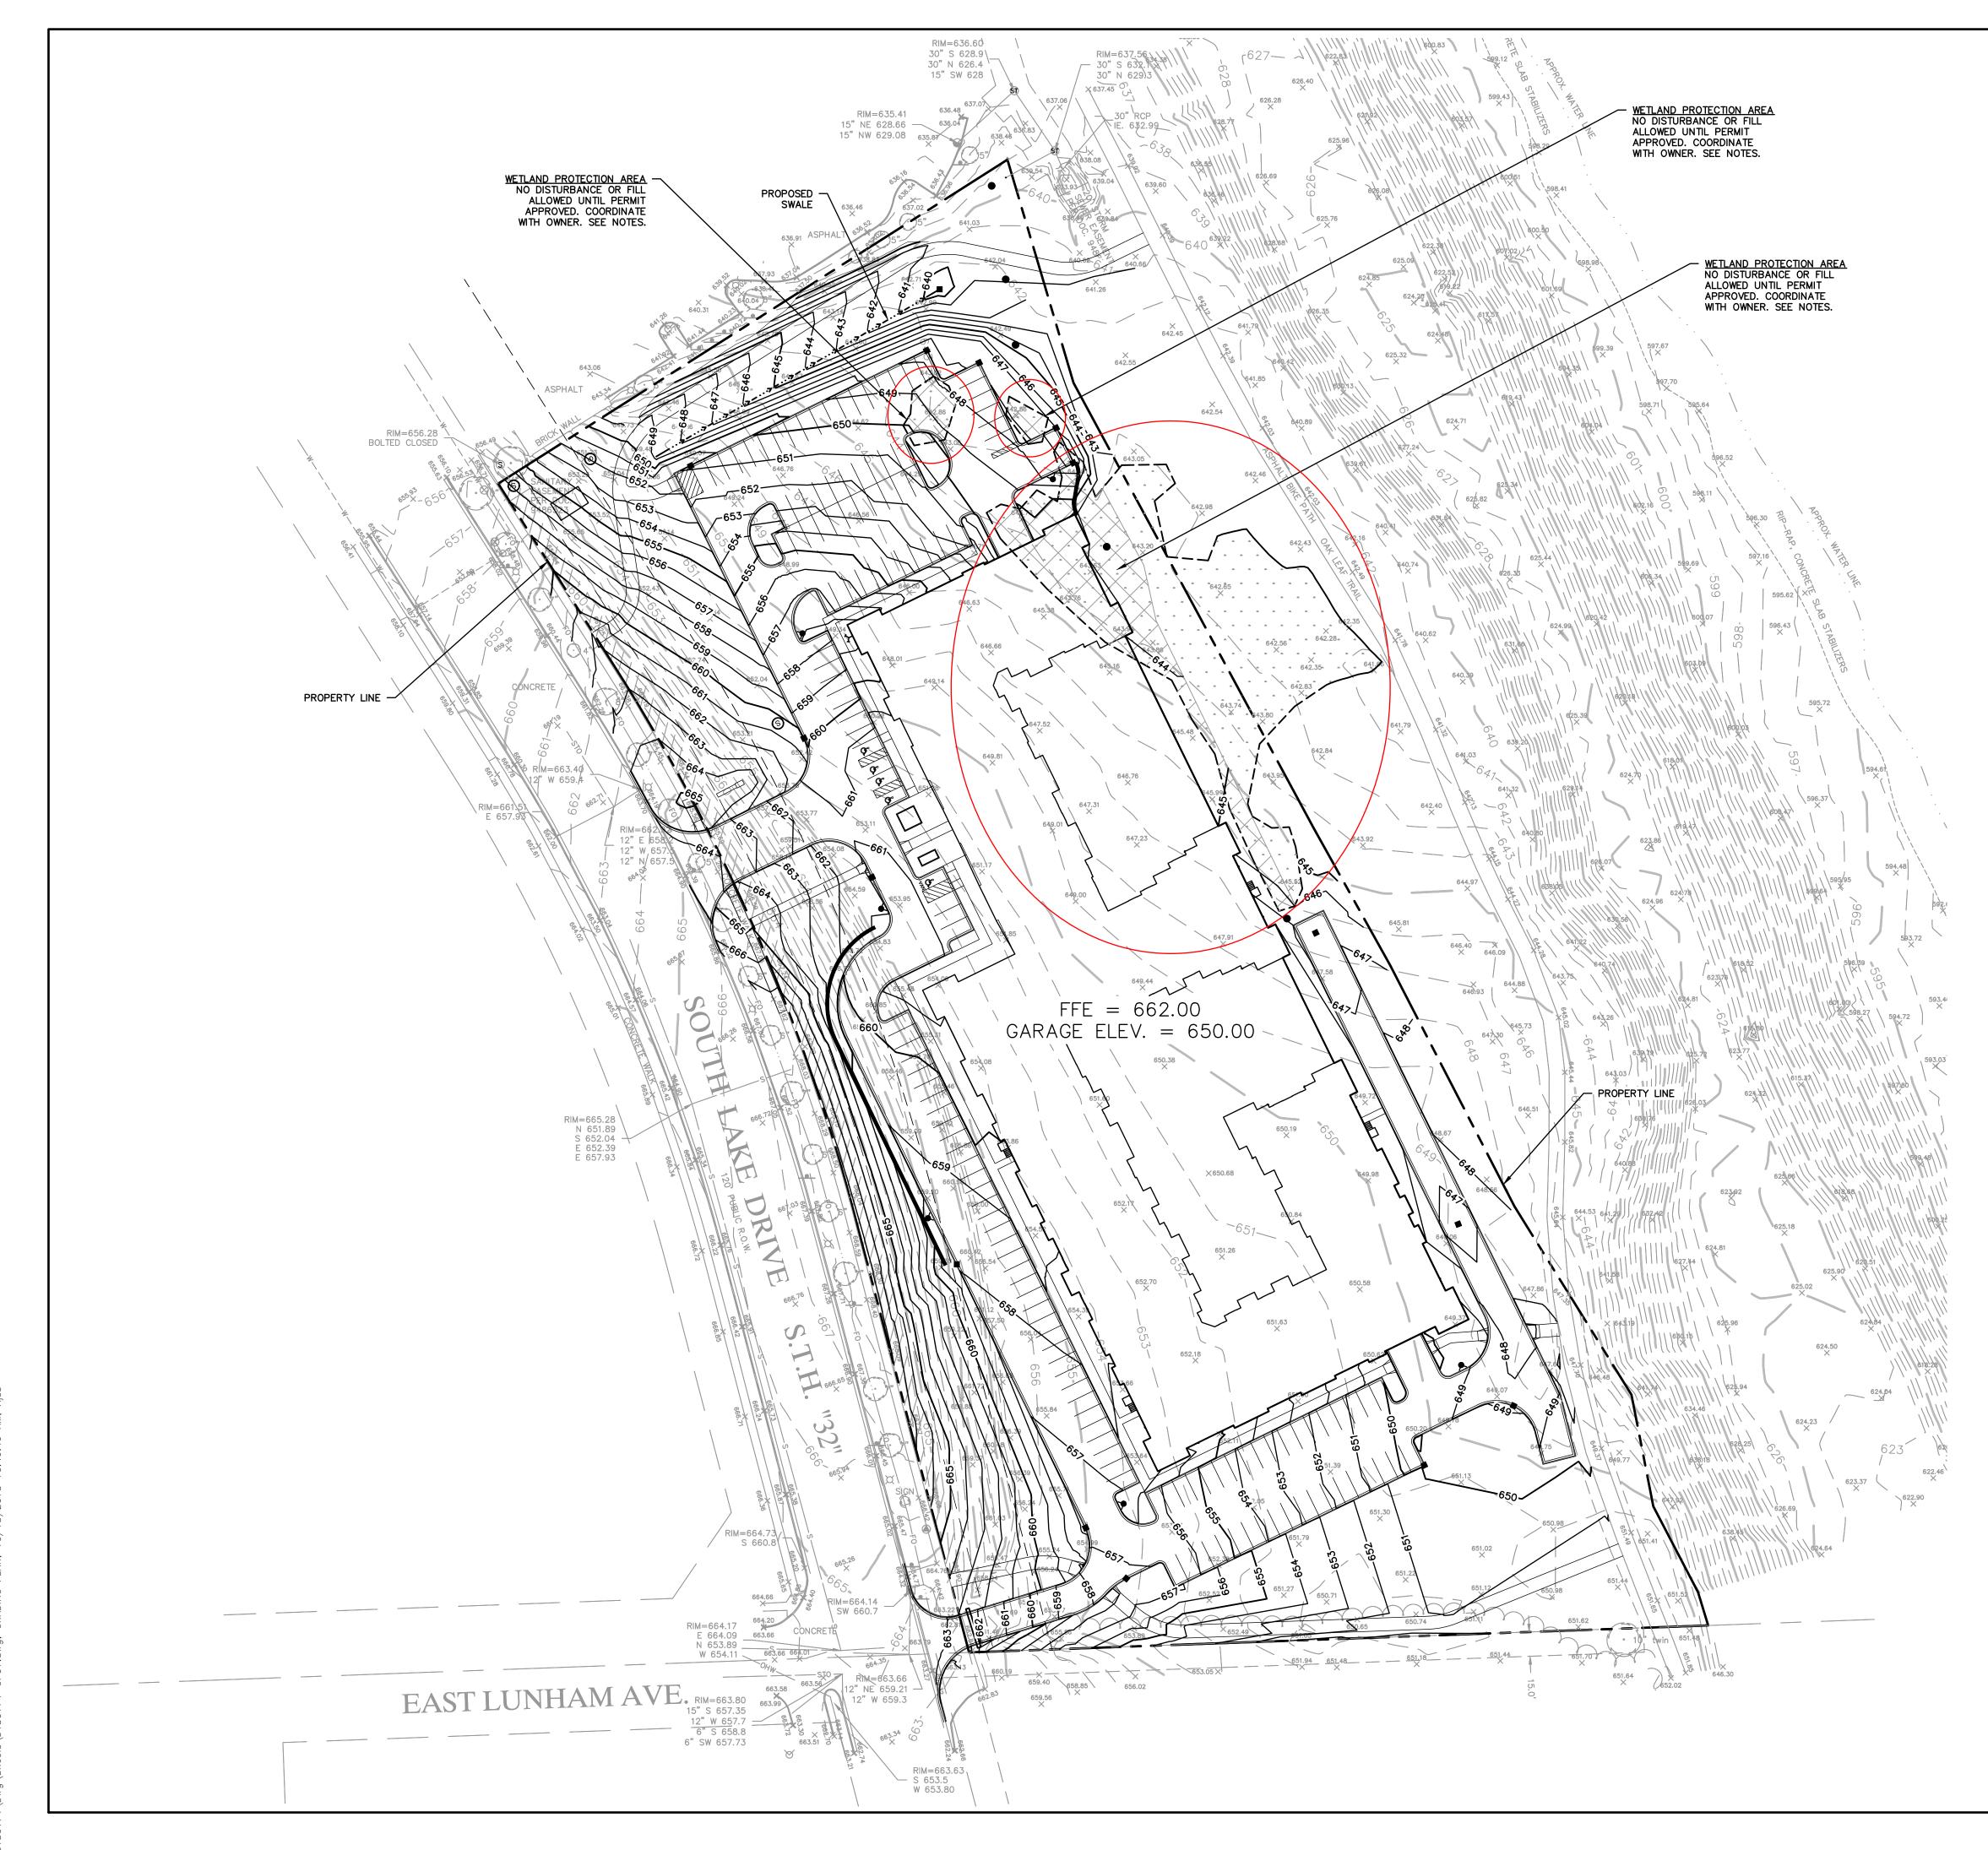

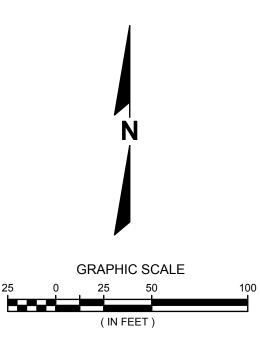

NOTES

TW/BW GRADES CORRESPOND TO THE GROUND OR PAVEMENT ELEVATIONS AT THE WALL. T/W GRADE IS THE ELEVATION AT THE WALL ON THE HIGH SIDE. B/W GRADE IS THE ELEVATION AT THE WALL ON THE LOW SIDE. TOP OF THE RETAINING WALL MAY BE HIGHER THAN THE PAVEMENT. FOR DOCK WALLS, SEE ARCHITECTURAL PLANS FOR THE RETAINING WALL HEIGHT.

WETLAND NOTES

1. WETLAND FILL PERMIT WILL BE APPLIED FOR THROUGH WDNR & ARM CORPS OF ENGINEERS.

2. CONTRACTOR SHALL NOT ENTER, GRADE, STOCKPILE, OR DISTURB THE WETLAND AREAS IN ANY WAY PRIOR TO RECEIPT OF WETLAND FILL PERMIT.

3. CONTRACTOR SHALL OBTAIN WETLAND FILL PERMIT FROM OWNER UPON PERMIT ISSUANCE.

4. CONTRACTOR IS RESPONSIBLE TO BE AWARE OF ALL PERMIT REGULATIONS AND COMPLY WITH ALL APPLICABLE EROSION CONTROL, STORM WATER, AND WETLAND PERMIT REQUIREMENTS.

100	TE DESCRIPTION								
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			CITY OF ST. FRANCIS. WI			OVERALL GRADING PLAN			
LATIONS AS THERE MAY TIONS SHOWN. WBILITY FOR ING FROM HIS PLAN ISENT OF	© COPYRIGHT 2018 R.A. Smith, Inc. DATE: 10/18/2018 SCALE: 1" = 50' JOB NO. 3180174 PROJECT MANAGER: TOM MORTENSEN PLA, ASLA DESIGNED BY: AJS3 CHECKED BY: PVM SHEET NUMBER C 200								



Know what's **below. Call** before you dig.

THE LOCATIONS OF EXISTING UTILITY INSTALLATIONS AS SHOWN ON THIS PLAN ARE APPROXIMATE. THERE MAY BE OTHER UNDERGROUND UTILITY INSTALLATIONS WITHIN THE PROJECT AREA THAT ARE NOT SHOWN.

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